

#8
VILLA ROAD

Hamilton, Massachusetts 01982


PREPARED FOR:

SILAS
G.
NARY

HANCOCK
ASSOCIATES

Civil Engineers
Land Surveyors
Wetland Scientists

121 EAST BERKELEY STREET, BOSTON, MA 02118
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NO.	BY	APP	DATE	ISSUE/REVISION DESCRIPTION
4.	JAE		12/1/21	REVISED MITIGATION AREAS
3.	JAE		11/30/21	REVISED MITIGATION AREAS
2.	JAE		11/18/21	ADD EROSION CONTROLS & PROPOSED MITIGATION AREA
1.	JAE		11/11/21	PROPOSED GARAGE REVISED

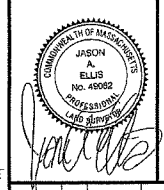DATE: 11/04/20 DRAWN BY: KNB
SCALE: AS SHOWN CHECK BY: JAE

PARTIAL
TOPOGRAPHIC
PLAN OF LAND
IN
HAMILTON, MA

PROJECT NO.: 21565

ASSESSORS:

MAP 71, LOT 14

REFERENCES:

DEED BOOK 33623, PAGE 288
PLAN BOOK 294 PLAN 91

NOTES:


- ELEVATIONS SHOWN HEREON ARE BASED ON AN ASSUMED DATUM
- LIMITS OF BORDERING VEGETATED WETLANDS SHOWN HEREON WERE DELINEATED BY HANCOCK ASSOCIATES ON 8/13/18 AND LOCATED BY FIELD SURVEY
- UTILITIES SHOWN HEREON FROM FIELD LOCATIONS OF SURFACE STRUCTURES. NO UNDERGROUND UTILITIES WERE INCLUDED AS PART OF THIS SURVEY. IT SHALL BE THE RESPONSIBILITY OF THE DESIGN ENGINEER AND THE CONTRACTOR TO VERIFY THE LOCATION, SIZE & ELEVATION OF ALL UTILITIES WITHIN THE AREA OF PROPOSED WORK AND TO CONTACT "DIG-SAFE" AT 811 AT LEAST 72 HOURS PRIOR TO ANY EXCAVATION, DEMOLITION OR CONSTRUCTION.

LEGEND

- x 100.7 SPOT ELEVATION
- 93.7 PROMINENT DECIDUOUS TREE WITH ELEVATION, SIZE AND SPECIES
- 96.2 PROMINENT CONIFEROUS TREE WITH ELEVATION, SIZE AND SPECIES
- FF FINISHED FLOOR
- ☆ LIGHT POLE
- (FD) FOUND
- I.P.I.P.E. IRON PIPE
- I.ROD IRON ROD
- BIT. CONC. BITUMINOUS CONCRETE
- - - 102 SURFACE CONTOUR
- - - EDGE OF PAVEMENT
- - - EDGE OF WOODED AREA
- #181 OHW EXISTING UTILITY POLE WITH DESIGNATION OVERHEAD WIRES AND GUY POLE
- RETAINING WALL
- WFA2 LIMIT OF BORDERING VEGETATED WETLAND WITH FLAG NUMBER
- LIMIT OF 100-FOOT WETLAND BUFFER ZONE
- - - EDGE OF GRAVEL ROAD

TREE ABBREVIATIONS


- M MAPLE
- O OAK
- P PINE
- BR BIRCH

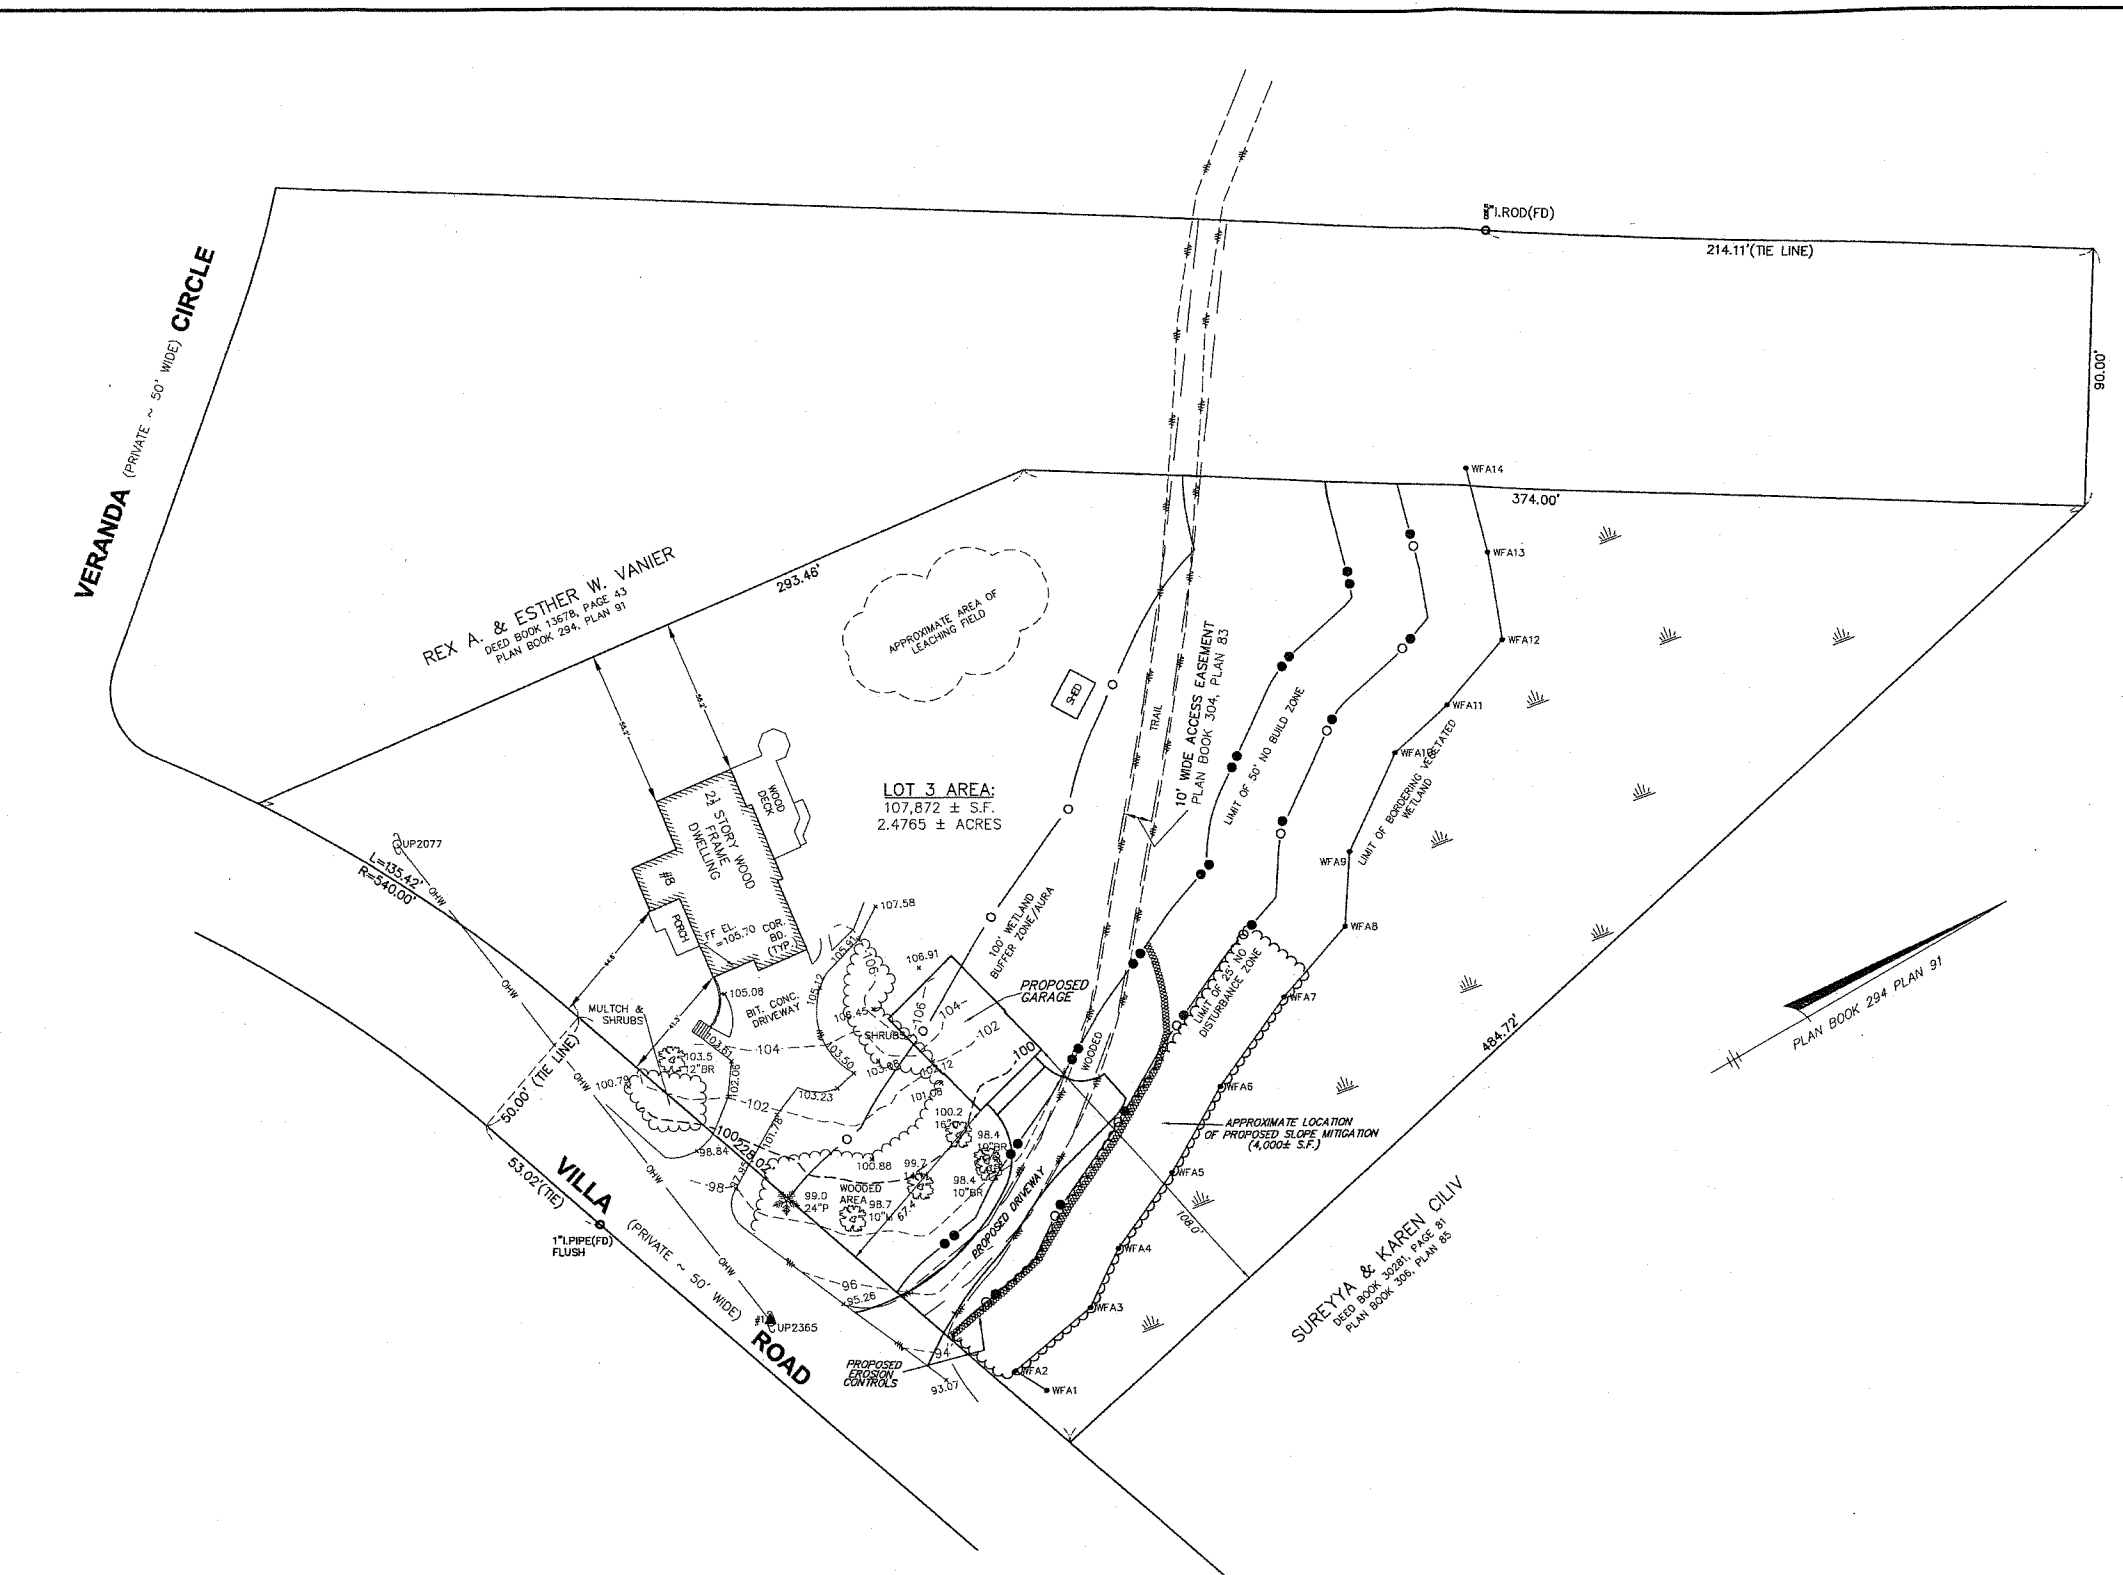


ELEVATION BENCH MARKS	
DATUM: ASSUMED	
NO.	DESCRIPTION
1.	NAIL SET ON U-POLE #2365
2.	
3.	

SCALE: 1" = 30'

DATE: 11/04/20 DRAWN BY: KNB
SCALE: AS SHOWN CHECK BY: JAE
DWG: 21565ec.dwg
LAYOUT: BOS-EC
SHEET: 1 OF 1

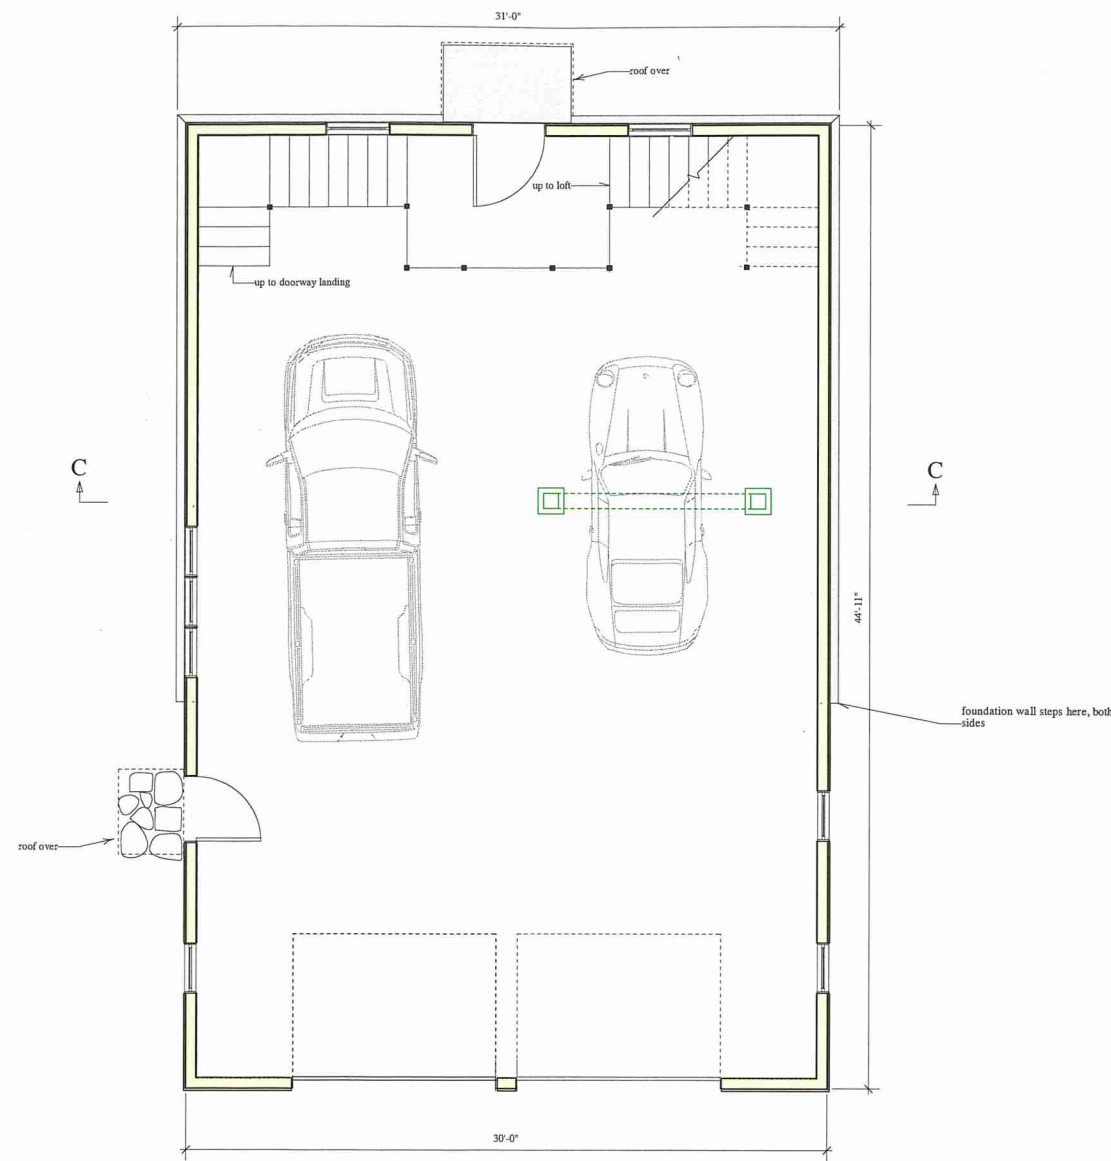

Ground Floor

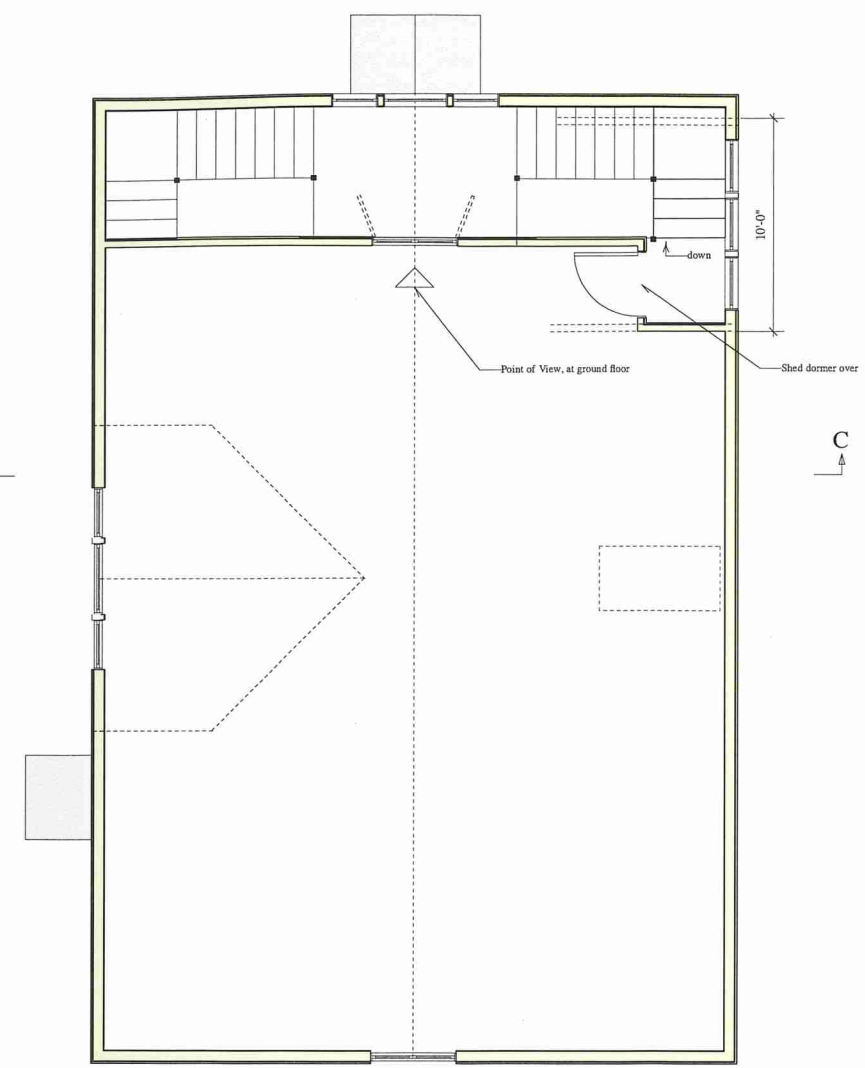

Loft Floor

Unit	Qty.	Model	Rough opening	Notes
A	1	Velux S06	44-3/4" w. x 46-1/4" h.	
B	3	ELAWN2935	2' 5" w. x 2' 11-5/8" h.	separated by (2) 2x4 studs each.
C	3	ELCA2955	2' 5" w. x 4' 7-5/8" h.	
D	1	ELAWN2929	2' 5" w. x 3' 3-5/8" h.	
E	2	ELCAP2547	2' 1" h. x 3' 11-5/8" h.	three unit assembly, separated by (2) 2x4 studs each.
F	1	ELCAP3747	3' 1" w. x 3' 11-5/8" h.	
G	2	ELAWN2935	2' 5" w. x 2' 11-5/8" h.	Muntin pattern different than units "B", which are same size
H	1	Door	slab size 3' 6" x 6' 10"	Wood door by Simpson or equal
I	1	ELCA2971	4' 9" w. x 5' 11-5/8" h.	
J	2	elliptical transom	frame 9' 6" w. x 2' 10"	special order by Marvin or other
K	2	ELCA2959	2' 5" w. x 4' 11-5/8" h.	
L	1	ELCAP4159	3' 1" x 4' 11-5/8"	three unit assembly, separated by (2) 2x6 studs each.
M	1	ELAWN2939-3W	7' 1" x 3' 3-5/8"	
N	1	Door	slab size 3' 0" x 6' 10"	Wood door by Simpson or equal

- Notes:
1. Include window screens.
 2. Fine interior, primed.
 3. Simulated divided light, 5/8" muntins, with silver spacer bar.
 4. Interior hardware to have "antique brass" finish.
 5. Door screens options include Andersen's aluminum units or equal, or Brusco wood doors or equal.
 6. Elliptical transoms windows need not be clad exterior. Option for energy efficient glass: 'single strength' exterior storm panel.
 7. No extension jambs (until interior wall finishes decided).


Date: November, 2021
 Revise/ Update:
 December 20, 2021
 February 1, '22
 February 8, '22
 Feb. 16, '22
 Feb. 22, '22
 April 3, '22

33 Labor In Vain Road
 Ipswich, Massachusetts
 978-356-8679
 WeatherallDesign@gmail.com



Design of a Barn
 for the
 Nary Family
 8 Villa Road, Hamilton, Massachusetts

Floor Plans
 and
 Window and Door Schedule
 Scale: 1/4 inch = 1 foot, or as noted.

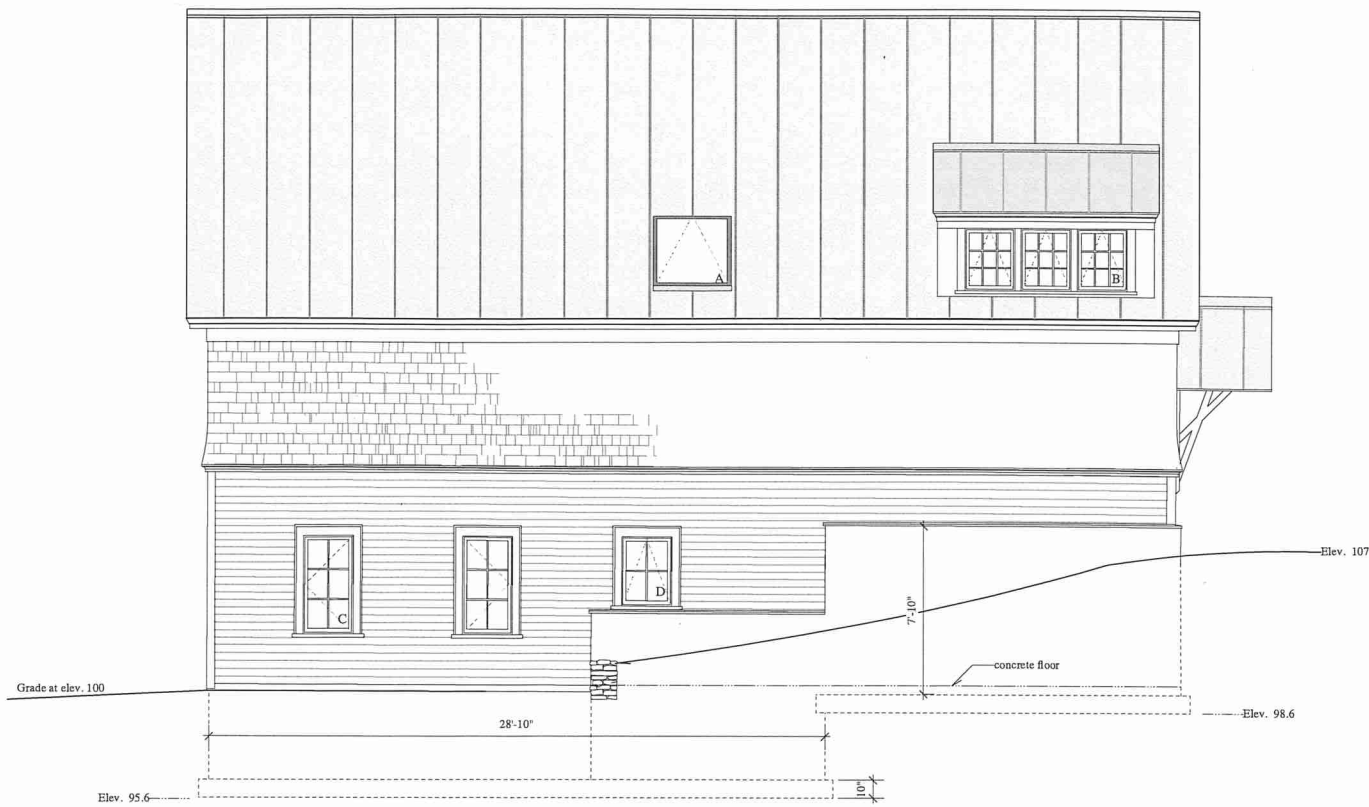

North



West



East



South

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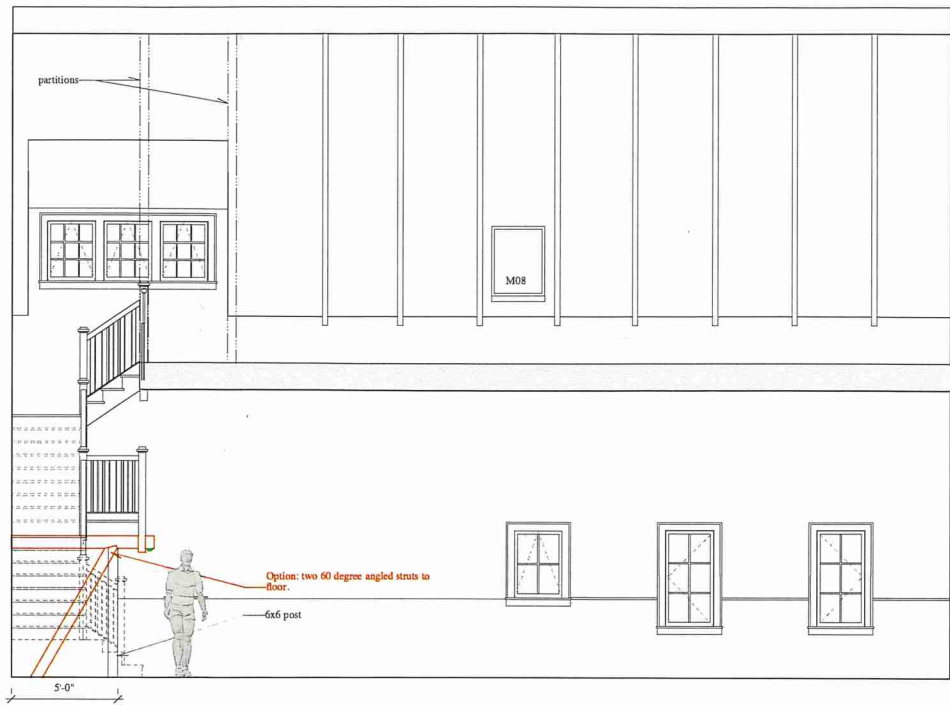
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Elevations
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A2



Outline of Specifications

Foundation:
 Poured concrete, 10" thick, as per detail sections.

Framing:
 As per framing plans. 2x6 spruce/hemlock/fir studs. "J-join" floor framing.
 Wall sheathing to be plywood.

Exterior Finishes:
 Trim: red cedar C-and-better, sound and tight knots (STK), PISSE, or designer and owner approved equal. Pre-primed and painted. Seal all cuts before installation.
 White cedar shingles, pre-stained to match the house.
 Clapboards to be clear white pine, pre-painted or stained to match the house. Alternate: standard red cedar.

Exterior Flashings:
 Red copper, and/or zinc, and lead.

Roof:
 Standing seam aluminum, Kynar finished.
 First alternate: standing seam steel.
 Second alternate: laminated asphalt shingles.

Windows and doors:
 By Marvin, aluminum clad, "Ultimate" series as per door and window schedule.
 1st alternate: Marvin's "Elevate" series.
 2nd alternate: Kolbe or Jeld-Wen windows or equal, either aluminum or fiberglass clad exterior.
 Exterior doors: by Simpson or equal, such as Rogue Valley
 Overhead garage doors: as per elevation drawings (design details pending). Hardware to match door weight with finishes.

Insulation:
 Closed cell spray foam at all locations.
 Alternate: "Rockwool" or equal mineral wool at walls and between floors.

Heating, Cooling:
 Air source heat pump system.



Floors:
 Poured concrete at ground floor, as shown in section drawing.
 Stair assembly: ash.
 Loft floor: white pine, tongue and groove. Bona "Traffic" two part water base finish.

Walls and ceilings:
 Main floor and loft: eastern white pine, tongue and groove, prefinished with white stain and glazing.
 Alternate: 1/2" gypsum with veneer coat plaster.
 Ceiling at garage: per ICC building code requirements for garage and apartment fire protection.
 Workshop (ground floor) walls: pine and/or gypsum and plaster as above.

Cabinetry:
 Workbenches

Interior Doors and Hardware:

Lighting:

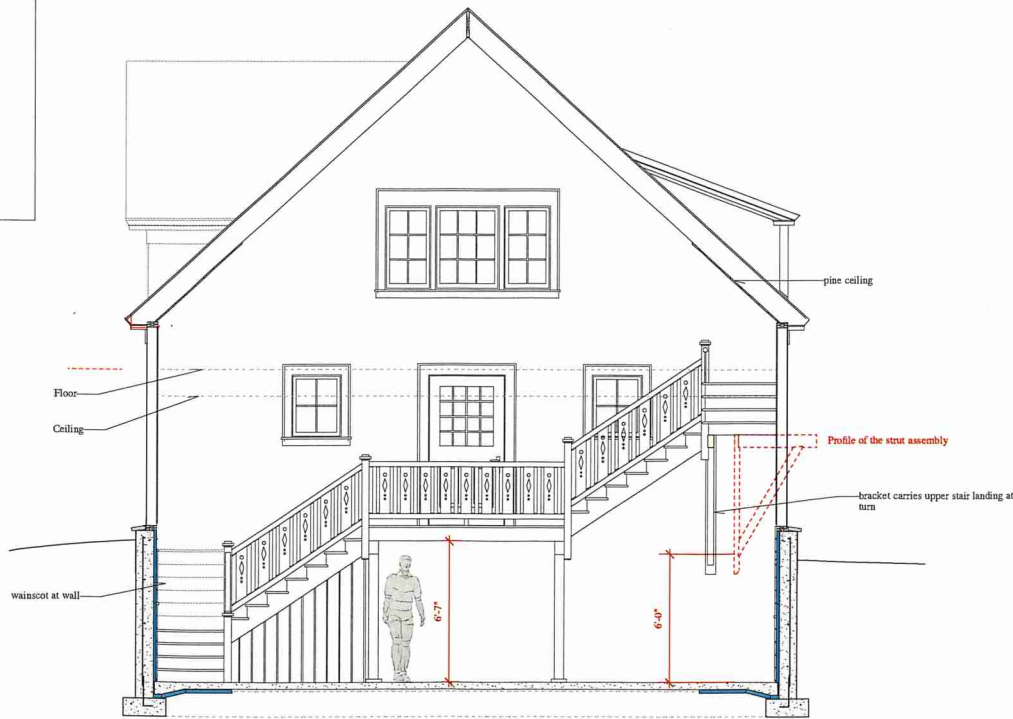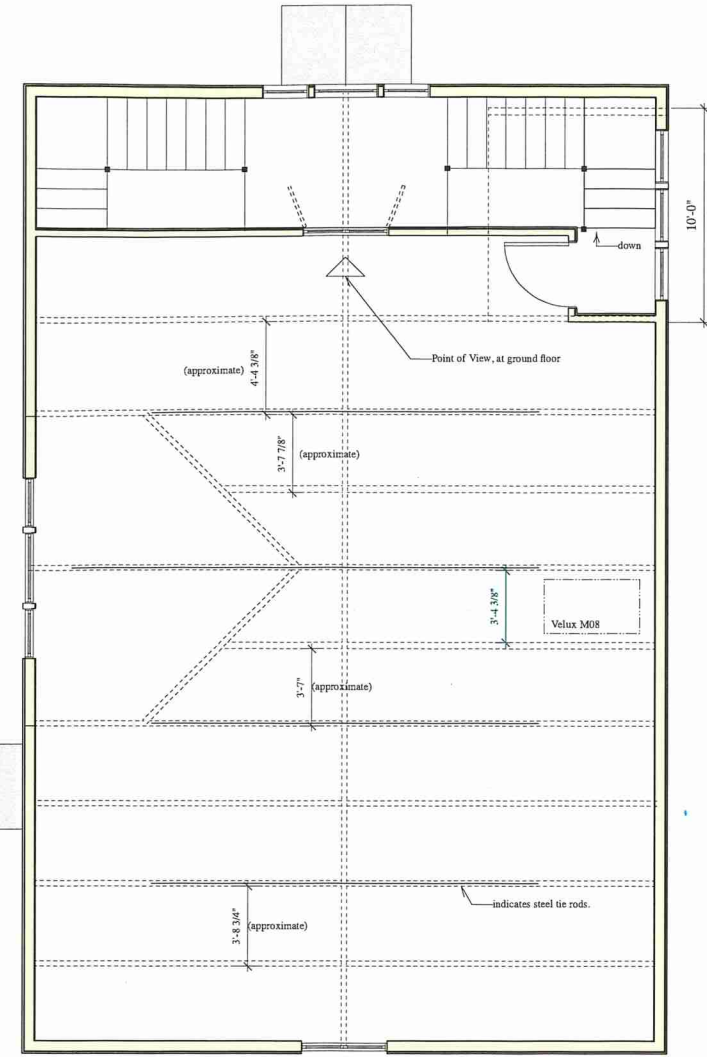

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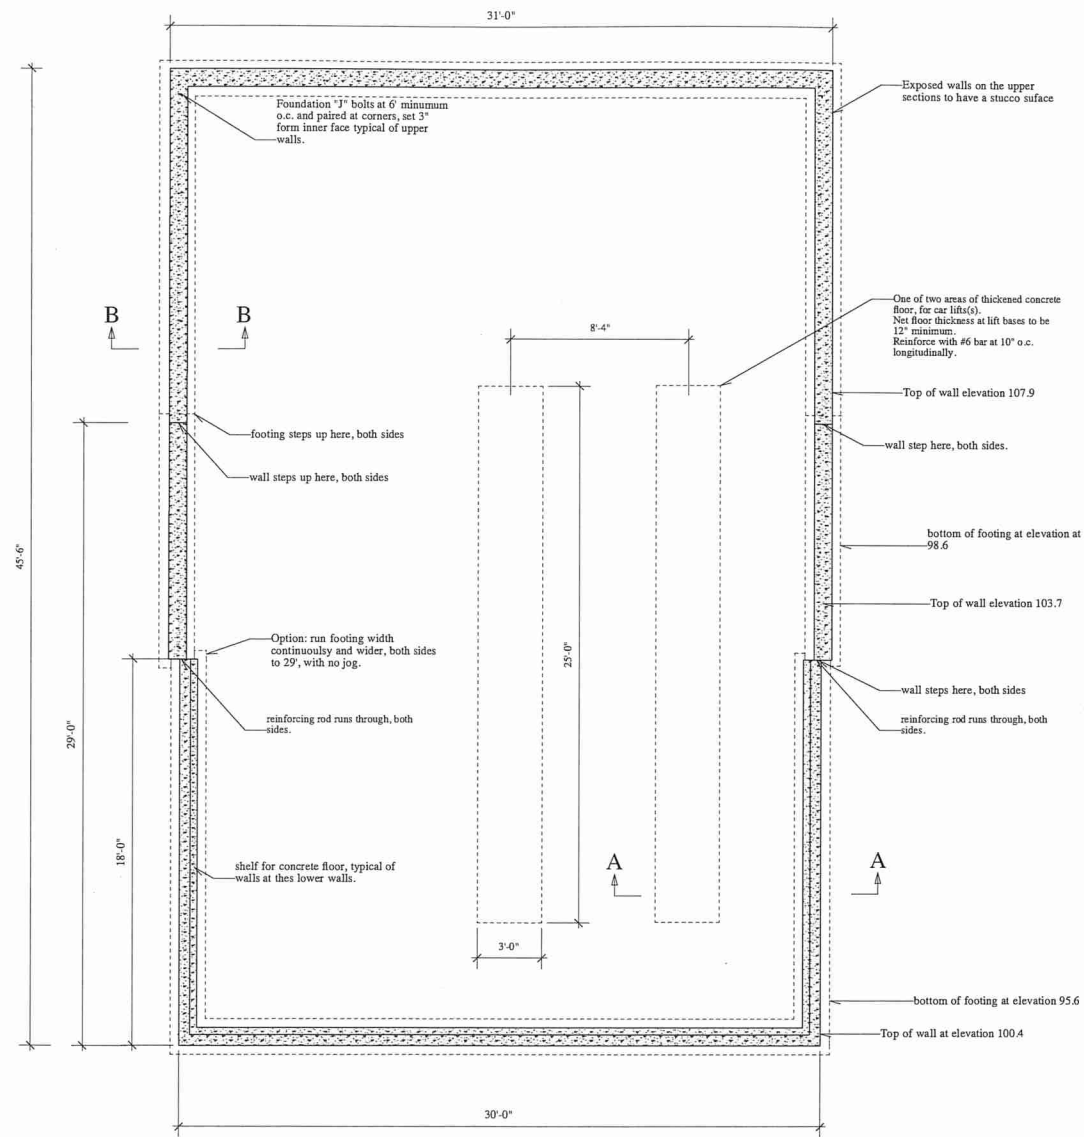
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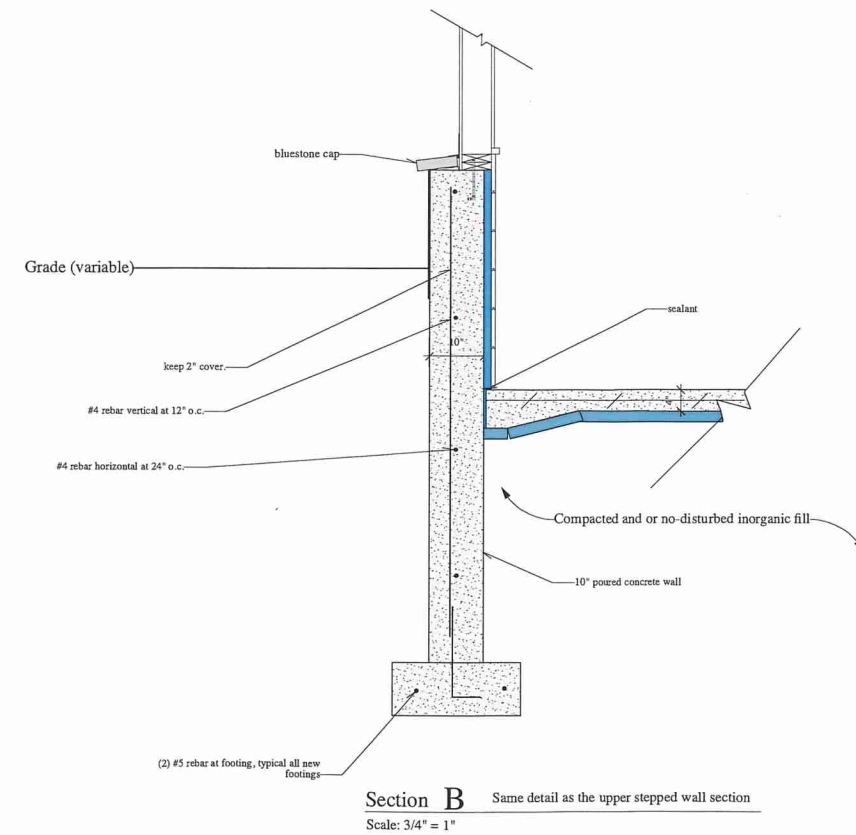
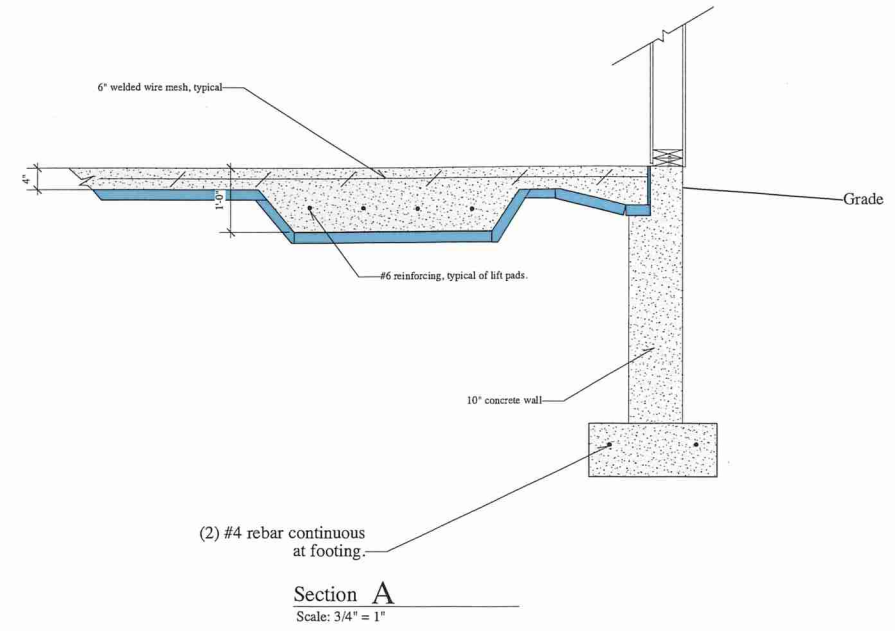
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Interior Elevations
Reflected Loft Ceiling Plan
 Scale: 1/4 inch = 1 foot, or as noted.

A3



Foundation Plan



Section B Same detail as the upper stepped wall section
Scale: 3/4" = 1"

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Concrete Foundation
 and
 Foundation Sections
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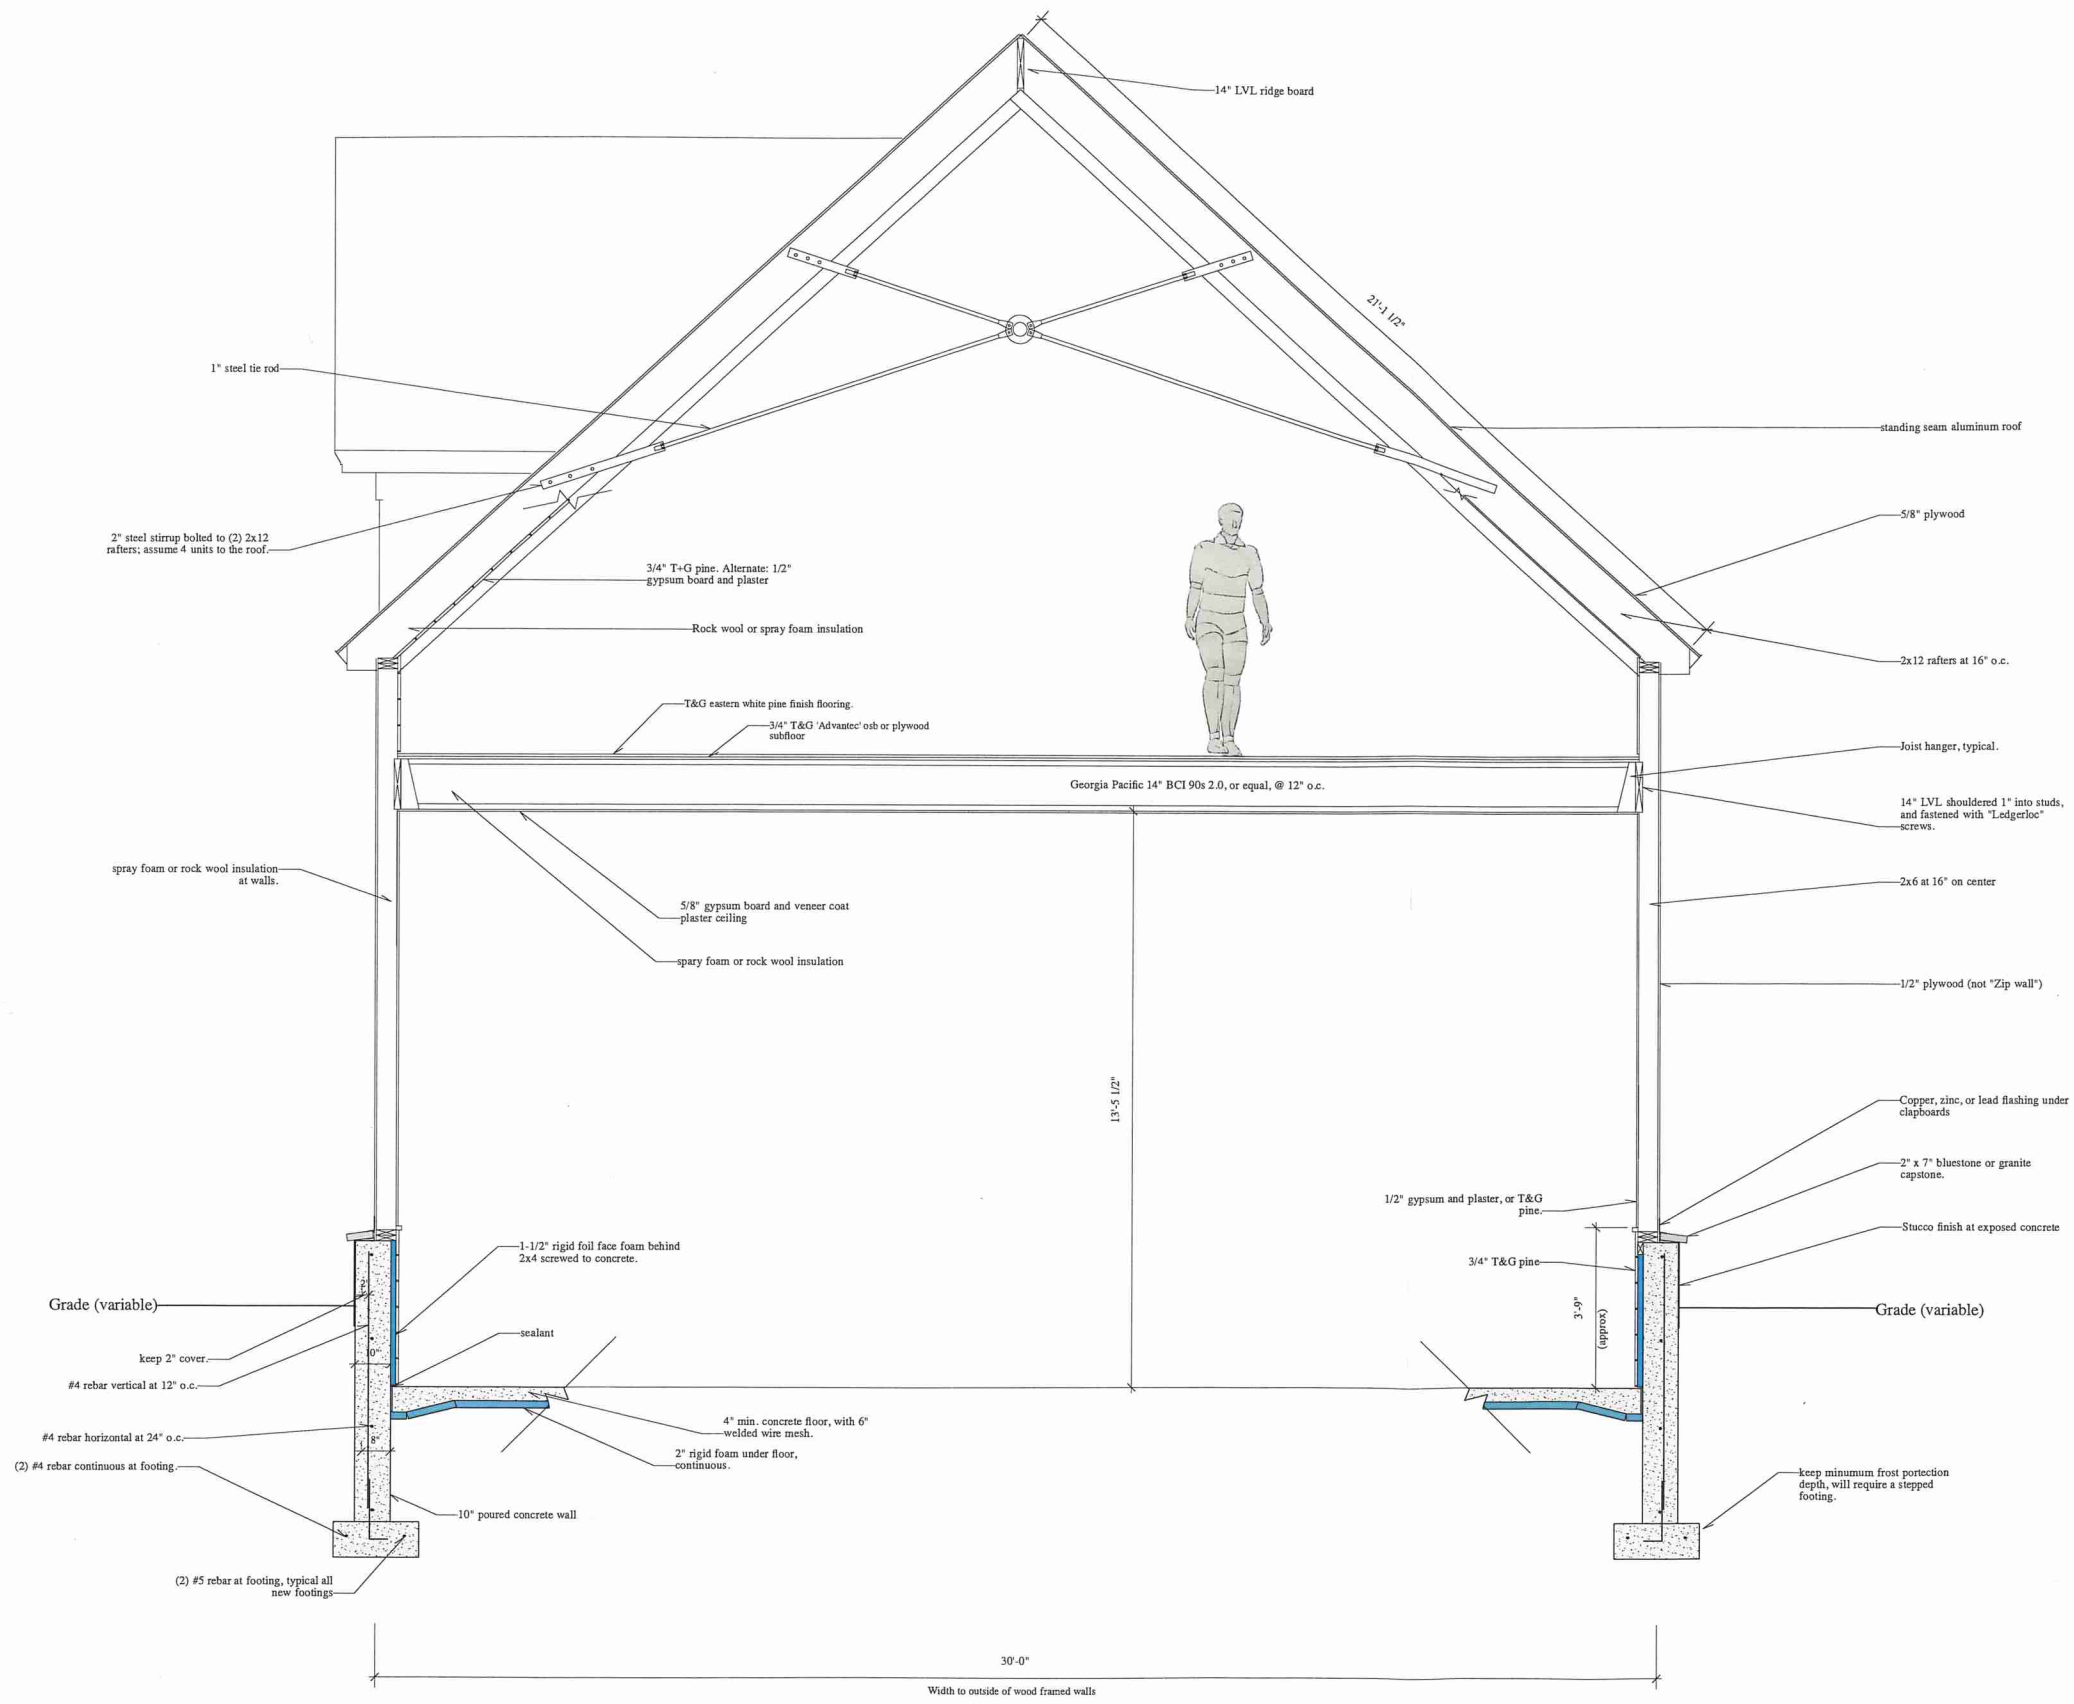
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Building Section
 Scale: 1/4 inch = 1 foot, or as noted.

S2



Section C
 Scale: 1/2 inch = 1 foot